

#### DATE: November 20, 2013

#### AGENDA ITEM # 2

**TO**: Bicycle and Pedestrian Advisory Commission

FROM: Sierra Davis, Assistant Planner

**SUBJECT**: Addition to an Existing Mixed-Use Building – 4940 El Camino

#### RECOMMENDATION:

Recommend approval of Commercial Design Review application 13-D-10 to the Planning and Transportation Commission for an addition to an existing mixed-use building.

#### **BACKGROUND**

In accordance with Council direction, the Bicycle and Pedestrian Advisory Commission (BPAC) advises the development review process on projects with bicycle and pedestrian components.

The City does not have a bicycle parking ordinance and uses the Valley Transportation Authority (VTA) Bicycle Technical Guidelines. The VTA Guidelines recommend office uses provide one space per 6,000 square feet. The total number of bicycle parking spaces should be distributed: 75 percent of the bicycle spaces should be Class I and 25 percent should be Class II. Restaurant uses require one Class I per 30 employees and one Class II per 3,000 sq. ft. A Class I space is defined as one that protects the entire bicycle and its components from theft, vandalism and/or inclement weather and is appropriate for long-term parking. A Class II space is defined as a rack to which the frame and at least one wheel can be secured with a user provided U-lock or padlock and cable and is appropriate for short-term parking.

#### **DISCUSSION**

This is a Commercial Design Review application for an addition of 3,679 to a mixed-use commercial and office building at 4940 El Camino Real. The existing use of the building is the Boardwalk restaurant and offices on the first story and offices on the second story. The project includes an addition of 915 square feet onto the front of the building facing El Camino Real for a new restaurant area on the first floor. The other addition of 2,764 square feet will be to the first and second story and include new office space, bathrooms, stairways and storage.

As recommended by the VTA Guidelines, the project should provide four bicycle parking spaces: two Class I and two Class II. The project provides a Class I bicycle locker at the rear of the building. The locker is dived diagonally and can store two bikes, which meets the requirement. There will also be a new Class II serpentine (wave) style bike rack at the front of the property by the pedestrian walkway to the building. The bike rack will provide at least 5 bicycle parking spaces which exceeds the VTA guideline of two Class II spaces. The project will also maintain the existing bike rack at the rear of the building in the parking lot which can hold up to eight bicycles. The existing bicycle rack

is referenced on the site plan, sheet La-11b and the new bicycle rack is shown on the landscape plan, sheet L1.1.

The project adds additional ADA parking spaces, landscaping area and new pedestrian connection from the sidewalk to the building. The existing configuration of the front yard requires pedestrians walking on the sidewalk to access the entrance by crossing the parking lot. The new design creates a pedestrian walkway from the sidewalk to the building entrance without having to walk in the parking lot. The new bicycle rack will be located adjacent to the pedestrian walkway at the front of the property.

The existing sidewalk and bicycle lane are proposed to remain along El Camino Real. The sidewalk and bicycle lane are consistent with the sidewalk and street tree pattern along El Camino Real and does not appear to require upgrading as a result of the project.

#### ENVIRONMENTAL REVIEW

This project is Categorically Exempt from California Environmental Quality Act subject to section 15301 for Existing Facilities. The project qualifies for the exemption because the project will be served by all existing infrastructure, is not located in an environmentally sensitive area and the addition is less than 10,000 square feet.



### Echo Serpentine Style Bike Parking

#### Echo Bike Racks

These popular serpentine style racks are rugged and space efficient. Allowing for parking from both sides of the rack, the echo can be embedded mount or surface flange mount.

#### Materials

Tubing - 2 3/8" dia. schedule 40 steel tubing Foot Plates - 7 1/2" dia. x 1/4" stainless steel

#### Sustainability and LEED

Echo bike racks have a minimum recycled material content of 84% of which 73% is post consumer content. This content may vary based on the product design, product material type, and interchangeable piece parts. All styles are 100% recyclable. For more information about SiteScapes sustainable products and policies, please refer to our environmental statement.


#### Choices

Choose five, seven, nine, eleven or thirteen capacity; embedded or surface mount; powdercoat, Duracoat, galvanized or stainless steel.

#### Echo bike parking options

Embedded Mount has both legs placed in core drilled holes 10" below surface grade. The holes are then filled with concrete to secure the bike rack

Surface Mount has a surface plate on both legs. When the bike rack is positioned it is secured with stainless steel anchor bolts. (customer supplied)

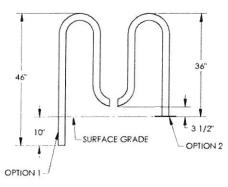



888.331.9464 402.421.9479 fax P.O. Box 22326 Lincoln, NE 68542 www.sitescapesonline.com info@sitescapesonline.com

#### Pictured this page

left: Echo seven space, surface mount bike rack EC2-07-SM (Brandy). top right: Echo thirteen space, surface mount bike rack EC2-13-SM-SF (Stainless). bottom right: Echo five space, embedded mount bike rack EC2-05-EM (Slate).


#### Finishes

SiteScapes offers product in both a standard powdercoat and its own proprietary Duarcoat finish. Both finishes are designed to weather the elements and are guaranteed not to rust, chip, peel, or fade. Call for a standard color chart.

#### www.sitescapesonline.com

For more information visit our website where you can download product drawings, photos, product brochures, CSI specs, and other technical data.

#### To Specify Echo Pike Parking

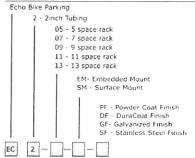







30% POST CONSUMER CONTENT



2175-8-P-C

# Super CycLoops Need CAD details or specifications? Contact us at sales@cycloops.info

Super CycLoops bike racks employ hefty 4-1/2" (115mm) diameter ASTM schedule 40 steel pipe with integral smaller steel dividers permanently welded in place. Two lengths are offered to accommodate eight (2175-8) or ten (2175-10) bicycles, each with embedment or pedestal (surface) mount option. Matching base covers are supplied with pedestal models only. Colorcoated, polished stainless steel or galvanized finished bike racks are available. See additional information and standard colors on page 7.








## CycLocker

The CycLocker is a modular bicycle storage cabinet 3'-3" (990mm) wide, 7'-4" (2235mm) long and 3'-10" (1170mm) high. Each module is diagonally separated to accommodate two bikes with access via a door on each end. Modules can be used separately or in linear combination with a shared common wall. The frame is tubular steel; the roof and walls are 16 gauge (1.5mm) steel sheet. Interior dividers are of 1/2" (13mm) medium-density overlaid marine plywood. Each door incorporates a stainless steel piano hinge and a heavy-duty key-locking latch assembly that features a dual top and bottom deadlock latch with an interior manual lock-release mechanism for safety. CycLocker modules are surface mounted using anchor bolts. Polyester color powder coating, two-toned color schemes or polished stainless steel finish options are available. See additional information and standard colors on





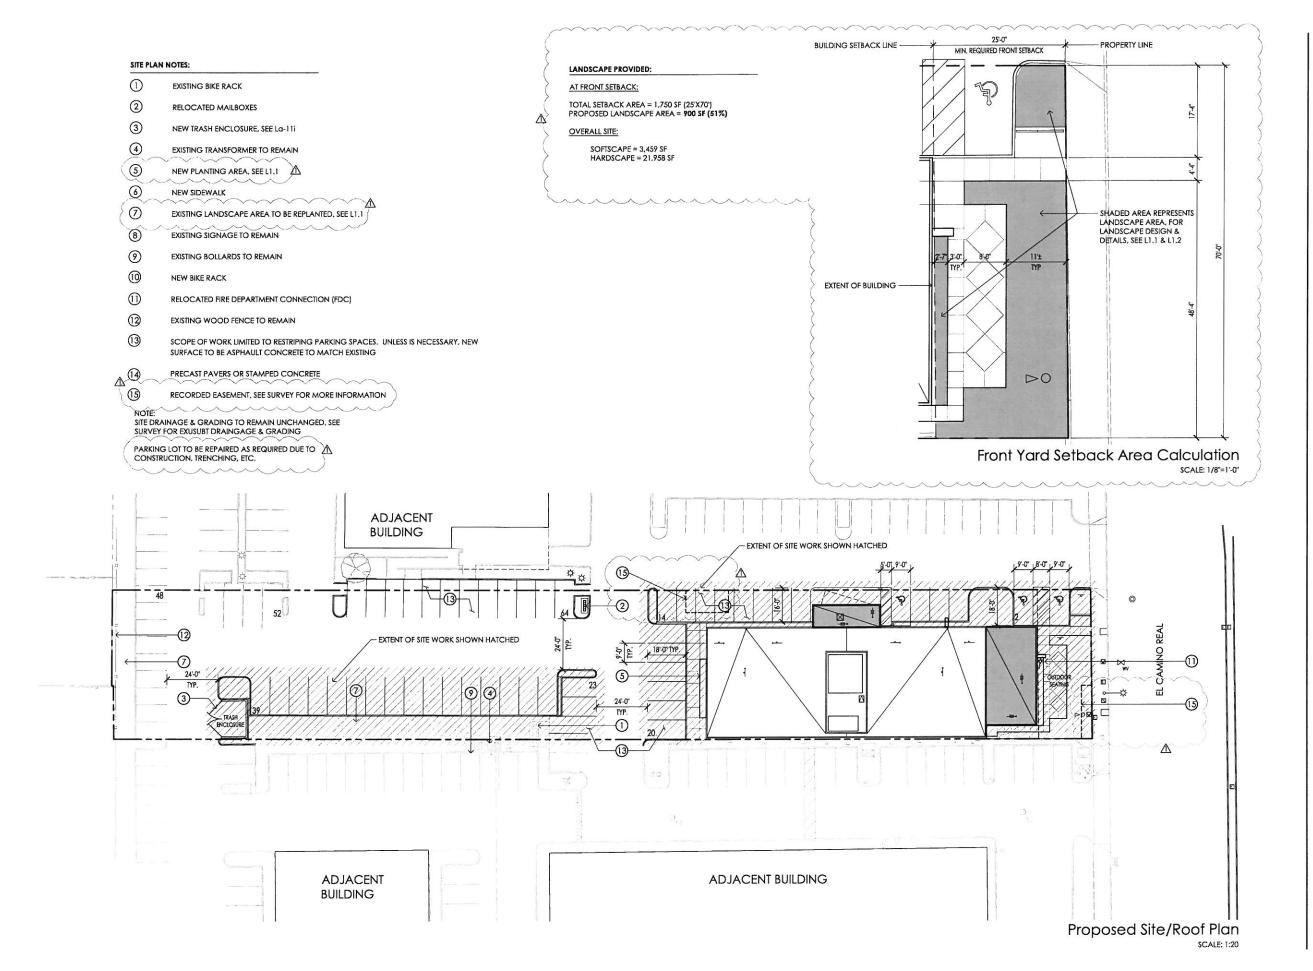

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**FORTY NINE FORTY** IMPROVEMENTS TO

SEAL

ISSUES:  $\Delta$ 



7-18-13

PROJECT NUMBER: V-13-01


DRAWN: ET CHECKED: CF 5-24-13

AS NOTED SCALE:

TITLE: SITE PLAN &

LANDSCAPE **PLAN** 

La-11b

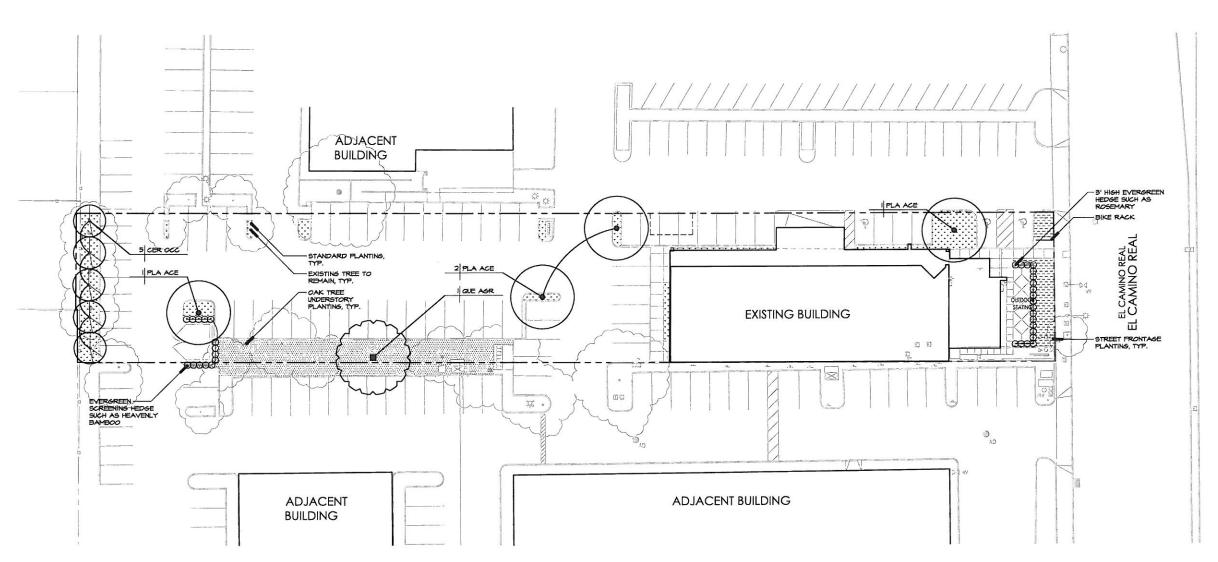

#### LANDSCAPE NOTES:

- ALL SHRUB AND GROUND COVER PLANTING AREAS TO HAVE 3" BFI PRO-CHIP BARK MULCH APPLIED TO FINISH GRADE.
- 2. ALL TREES SHALL BE MINIMUM 24" BOX SIZE.
- SOIL SAMPLES SHALL BE TAKEN AND SUBMITED TO A SOIL TESTING LABORATORY FOR ANALYSIS AND RECOMMENDATIONS, SOIL SHALL BE AMENDED PER LABORATORY ANALSYIS AND RECOMMENDATIONS.
- 4. NO INVASIVE PLANT SPECIES SHALL BE INSTALLED.
- A MINIMUM OF 15% OF THE FINAL PLANT LAYOUT WILL BE DROUGHT TOLERANT CALIFORNIA NATIVE AND/OR CLIMATE ADAPTED PLANTS,
- AN AUTOMATIC WEATHER-BASED IRRIGATION CONTROLLER WITH A SOIL MOISTURE AND/OR RAIN SENSOR SHALL BE INSTALLED AND CONTROL THE ENTIRE IRRIGATION SYSTEM.
- 1. SPRINKLER AND SPRAY HEADS WILL NOT BE INSTALLED IN PLANTING AREAS LESS THAN 8' WIDE.
- 8 PLANTS SHALL BE GROUPED ACCORDING TO WATER REQUIREMENTS AND PLACED ACCORDING TO MICRO-CLIMATE.

### SITE FURNISHINGS LIST

SYMBOL DESCRIPTION

BIKE RACK: SITESCAPES ECHO', EC-2-9-SM

#### LANDSCAPE CALCULATIONS

TOTAL HARDSCAPE AREA: 21,958 SF TOTAL SOFTSCAPE AREA: 4,449 SF

#### SHRUB AND GROUND COVER LIST

SYMBOL	BOTANICAL NAME	COMMON NAME	WATER REQUIREMENTS*
[2000000	STANDARD PLANTING		
	CISTUS X PURPUREUS	SAGELEAF ROCKROS	LOW
	CISTUS SALVIFOLIUS	ROCKROSE	LOW
	DESCHAMPSIA CAESPITOSA NORTHERN LIGHTS	TUFTED HAIRGRASS	LOW
L-1-1-1-1-1	ERIGERON KARVINSKIANUS	SANTA BARBARA DAISY	LOW
	GALVESIA SPECIOSA	ISLAND BUSH SNAPDRAGON	LOW
	HELICTOTRICHON SEMPERVIRENS	BLUE OAT GRASS	LOW
	LAYANDULA ANGUSTIFOLIA	LAVENDER	LOW
	MUHLENBERGIA RIGENS	DEERGRASS	LOW
	NANDINA DOMESTICA	HEAVENLY BAMBOO	LOW
	ROSMARINUS OFFICINALIS	ROSEMARY	LOW
	SALVIA LEUCANTHA	MEXICAN BUSH SAGE	LOW
	SANTOLINA CHAMAECYPARISSUS	LAVENDER COTTON	LOW
	OAK TREE UNDERSTORY PLANTING		
	CISTUS SALVIFOLIUS	SAGELEAF ROCKROSE	LOW
	DESCHAMPSIA GAESPITOSA NORTHERN LIGHTS'	TUFTED HAIRGRASS	LOW
	GALVESIA SPECIOSA	ISLAND BUSH SNAPDRAGON	LOW
kannanan in	HELICTOTRICHON SEMPERVIRENS	BLUE OAT GRASS	LOM
	MUHLENBERGIA RIGENS	DEERGRASS	LOW
	NANDINA DOMESTICA	HEAVENLY BAMBOO	LOM
	ROSMARINUS OFFICINALIS	ROSEMARY	LOW
	SALVIA LEICANTHA	MEXICAN BUSH SAGE	LOW
	SANTOLINA CHAMAECYPARISSUS	LAVENDER COTTON	LOM
[	STREET FRONTAGE PLANTING		
	CISTUS X PURPUREUS	ROCKROSE	LOW
	ARMERIA MARITIMA	SEA PINK	MODERATE
	CHONDROPETALUM TECTORUM	CAPE RUSH	MODERATE
	HEUCHERA SANGUINEA	CORAL BELLS	MODERATE
	LAVANDULA ANGUSTIFOLIA	LAVENDER	LOM
	PHORMIUM TENAX	NEW ZEALAND FLAX	MODERATE
	ROSMARINUS OFFICINALIS	ROSEMARY	LON
	SALVIA LEUCANTHA	MEXICAN BUSH SAGE	LOM
	SANTOLINA CHAMAECYPARISSUS	LAVENDER COTTON	LOM

COMMON NAME

WATER RECIPEMENTS

#### TREE LIST

SYMBOL	BOTANICAL NAME	COMMON NAME	WATER REQUIREMENTS
CER OCC	CERCIS OCCIDENTALIS - MULTI-TRUNK	WESTERN REDBUD	VERY LOW
PLA ACE	PLANTANUS ACERIFOLIA YARMOOD'	SYCAMORE	LOW
QUE AGR	QUERCUS AGRIFOLIA	COAST LIVE OAK	VERY LOW

MATER REQUIREMENTS TAKEN FROM WATER USE CLASSIFICATION OF LANDSCAPE SPECIES (MUCOLS) FROM A SUIDE TO THE WATER NEEDS OF LANDSCAPE PLANTS, UNIVERSITY OF CALIFORNIA COOPERATIVE EXTENSION, 1994, http://ucco.ucdavis.edu/files/fileibrary/1726/15359.pdf



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12.50		
14-54		
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LANDSCAPE PLAN

DATE: 07.18.2013

JOB NUMBER: 1319

DRAWN: EP CHECKED: AN

SCALE: AS NOTED

SHEET NUMBER

SCALE: I" = 20'-0"